



CONTROL VALVE CHAMBER

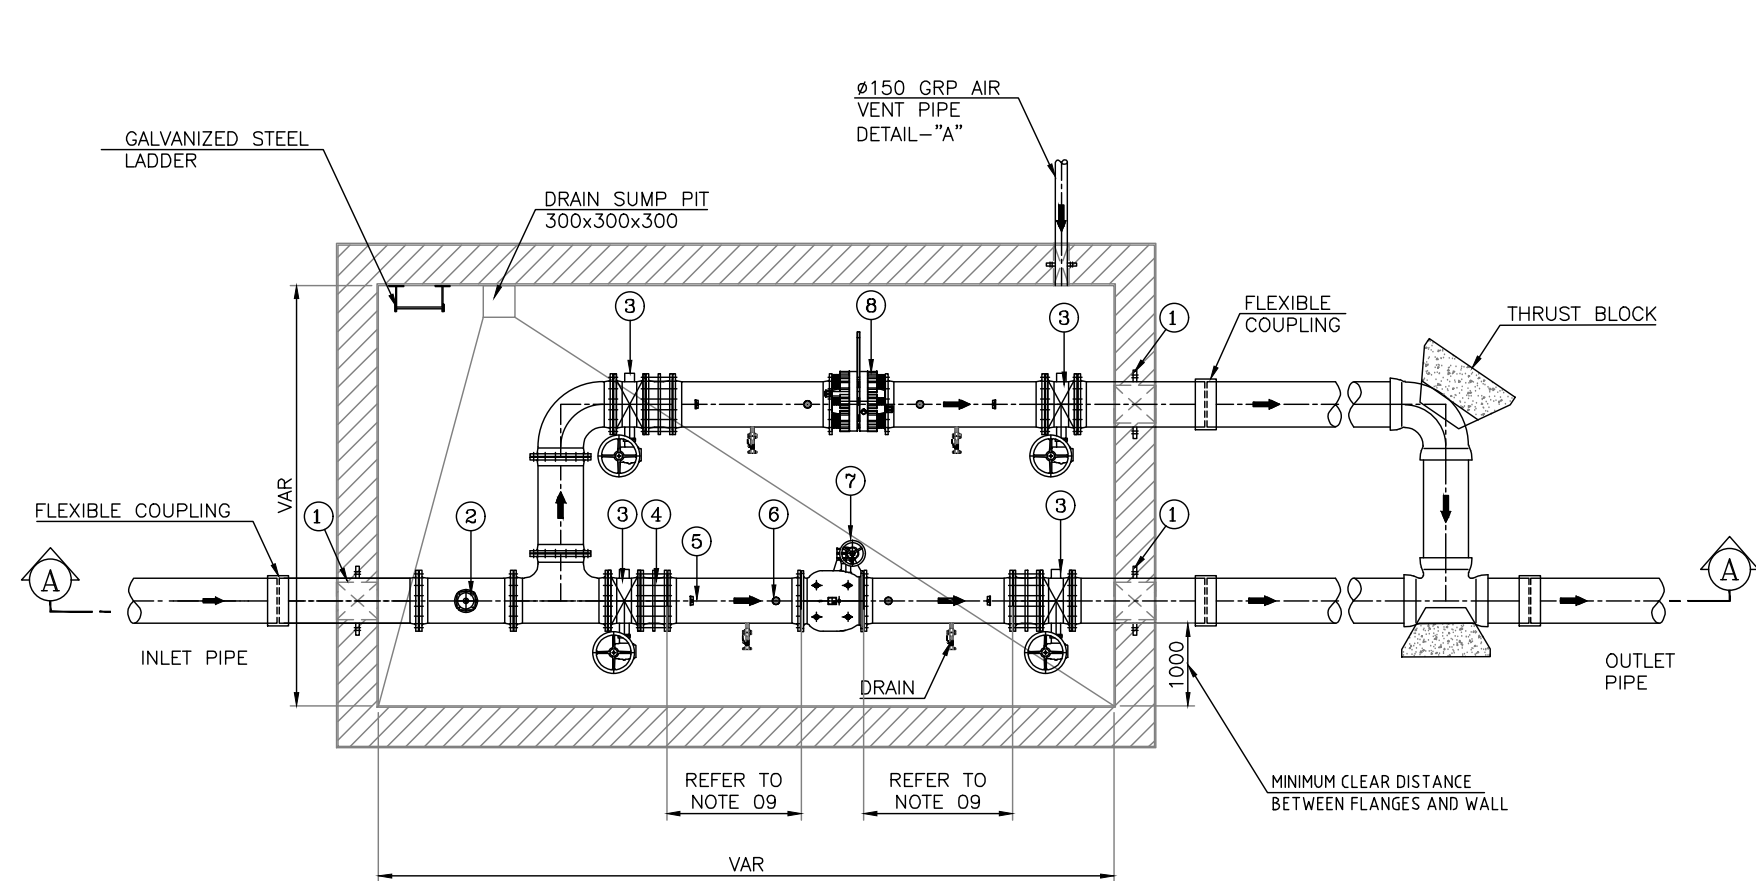


1 SECTIONAL PLAN


NO.	DESCRIPTION
1	PUDDLE PIECE
2	AIR VALVE
3	ISOLATION BUTTERFLY VALVE
4	DOUBLE FLANGED DISMANTLING JOINT
5	PRESSURE TRANSMITTER
6	PRESSURE SAFETY VALVE
7	DOUBLE FLANGED FLOW CONTROL VALVE (AXIAL FLOW PISTON TYPE)
8	ORIFICE PLATE

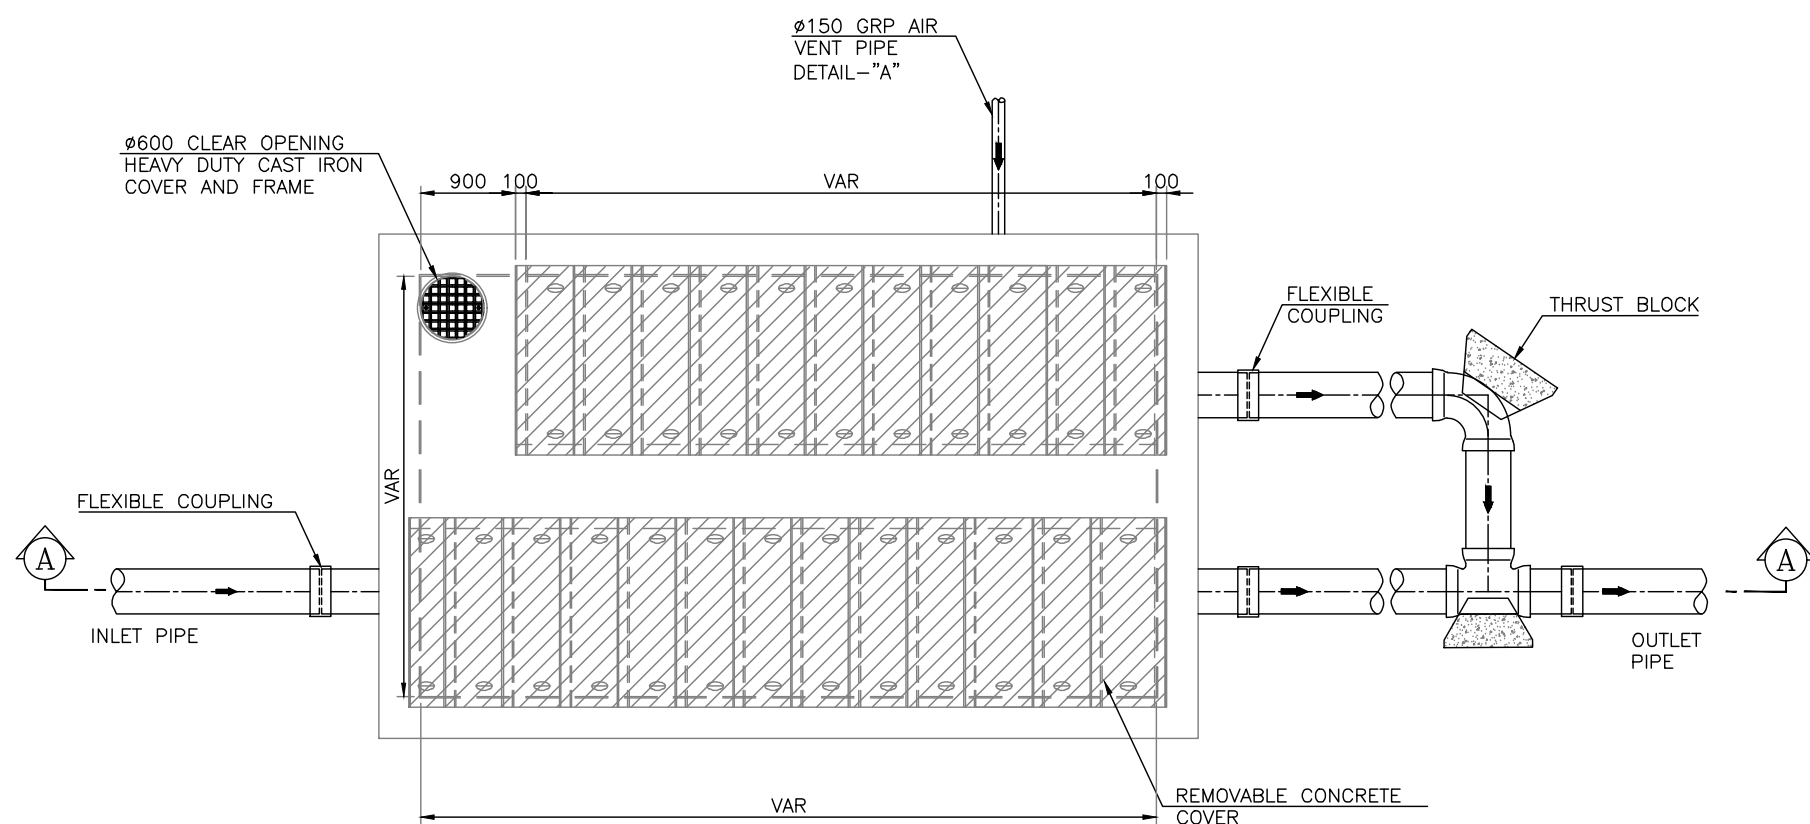

2 ROOF PLAN

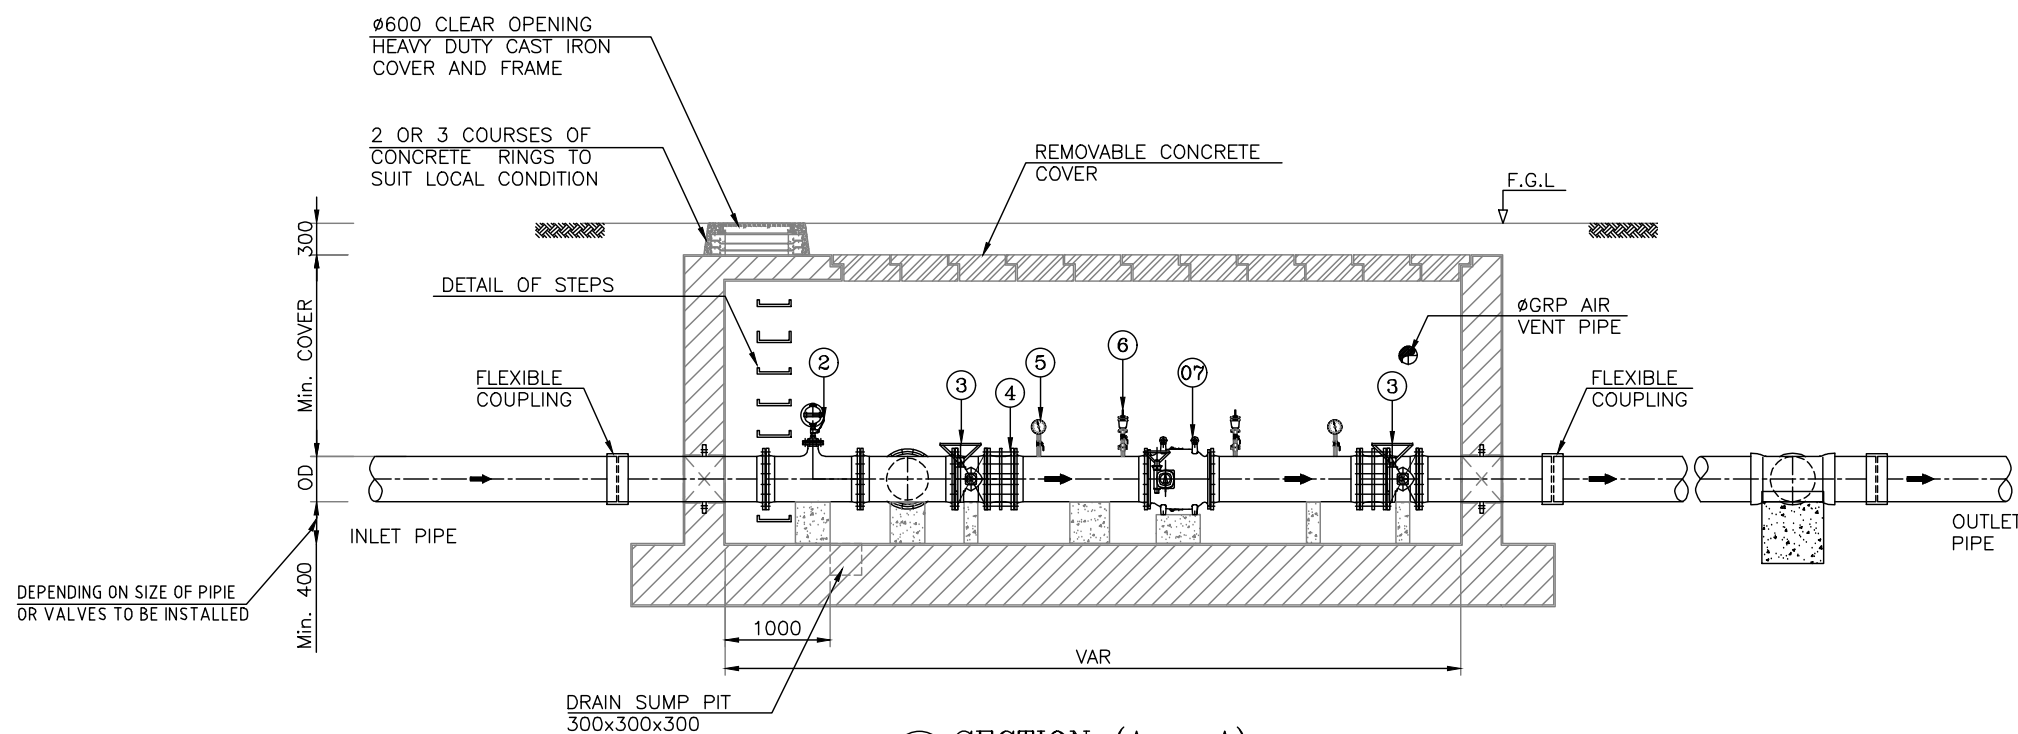

3 SECTION (A - A)

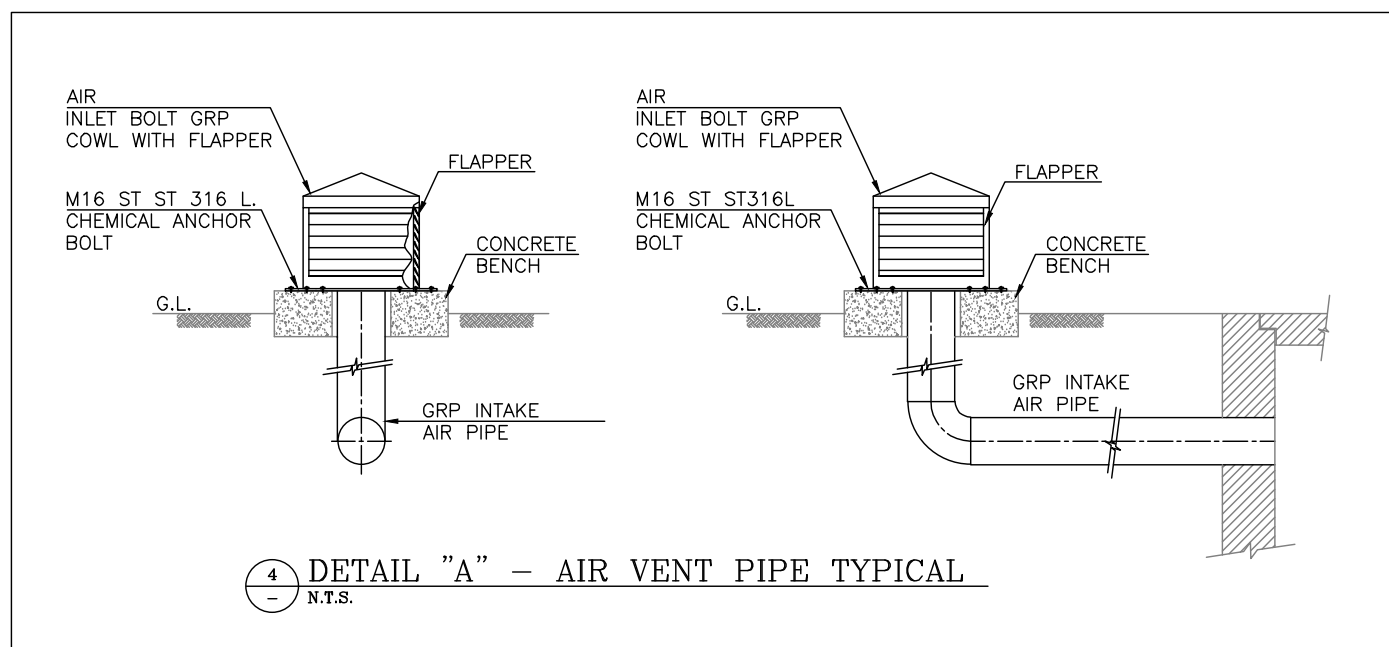

4 DETAIL "A" - AIR VENT PIPE TYPICAL

NOTES
01. ALL DIMENSIONS ARE TO BE READ AND NOT TO BE MEASURED.
02. ALL DIMENSIONS ARE IN MM UNLESS OTHERWISE NOTED.

FOR TENDER

CLIENT
MAHARASHTRA INDUSTRIAL TOWNSHIP LTD (MITL)

PROJECT
DESIGN, CONSTRUCTION, TESTING, COMMISSIONING AND OPERATION & MAINTENANCE OF INFRASTRUCTURE WORKS AT DIGHI PORT INDUSTRIAL AREA (DPIA)- PHASE 1 UNDER DELHI MUMBAI INDUSTRIAL CORRIDOR (DMIC) ON EPC BASIS

TITLE
TYPICAL DETAILS OF CONTROL VALVE CHAMBER

PROJECT CODE: D1628 STATUS: ISSUED FOR TENDER DATE: 18.12.2024

SHEET NO: 01 SCALE: NTS DWG SIZE: A2 REV NO: R0

DRAWING NO: MITL-DPIA-PKG1-SW-14