


NOIES

- 1-ALL DIMENSIONS & LEVEL ARE IN METERS UNLESS OTHERWISE INDICATED.
- 2-PIPE DIAMETERS ARE IN MILLIMETER.
- 3-THE REFERENCE LEVEL +0.00 IN ALL RESERVOIR RELATED DRAWINGS CORRESPONDS TO THE RESERVOIR FLOOR LEVEL.
- 4-ALL METALLIC WORKS ARE TO BE STAINLESS STEEL SS316 INSIDE THE RESERVOIR AND GALVANIZED STEEL OTHERWISE.
- 5-ALL VALVES MUST BE INSTALLED BENEATH THE PRECAST BEAMS LOCATIONS.
- 6-MINIMUM WATER LEVEL MWL=200mm
- 7-GATE VALVE MUST BE INSTALLED FOR PIPE DIAMETER LESS THAN 200mm AND BUTTERFLY VALVE FOR LARGER DIAMETER.
- 8-INLET VALVE SHALL BE ELECTRICALLY OPERATED.
- 9-DIAMETERS OF INLET, OUTLET, OVERFLOW AND DRAINS PIPING DEPENDS ON HYDRAULIC REQUIREMENT.
- 10-ALL DIMENSIONS ARE ONLY FOR GUIDANCE, AND THE CONTRACTOR MUST PROVIDE THE OWNER WITH THE FULL DETAILED DESIGN DRAWINGS IN ADAPTION TO THE SITE CONDITIONS AND THE SPECIFIC PROJECT REQUIREMENTS.

LEGEND

- 1 -INLET PIPE
- 2 -OUTLET PIPE
- 3 -ACCESS OPENING 900x900
- 4 -GALVANIZED STEEL CHECKED PLATE COVER
- 5 -GALVANIZED STEEL LADDER
- 6 -MAINTENANCE OPENING 2000X2000
- 7 -OVERFLOW & DRAIN PIPE
- 8 -VENTILATION PIPE
- 9- GARGOYLE FOR ROOF WATER DRAINAGE

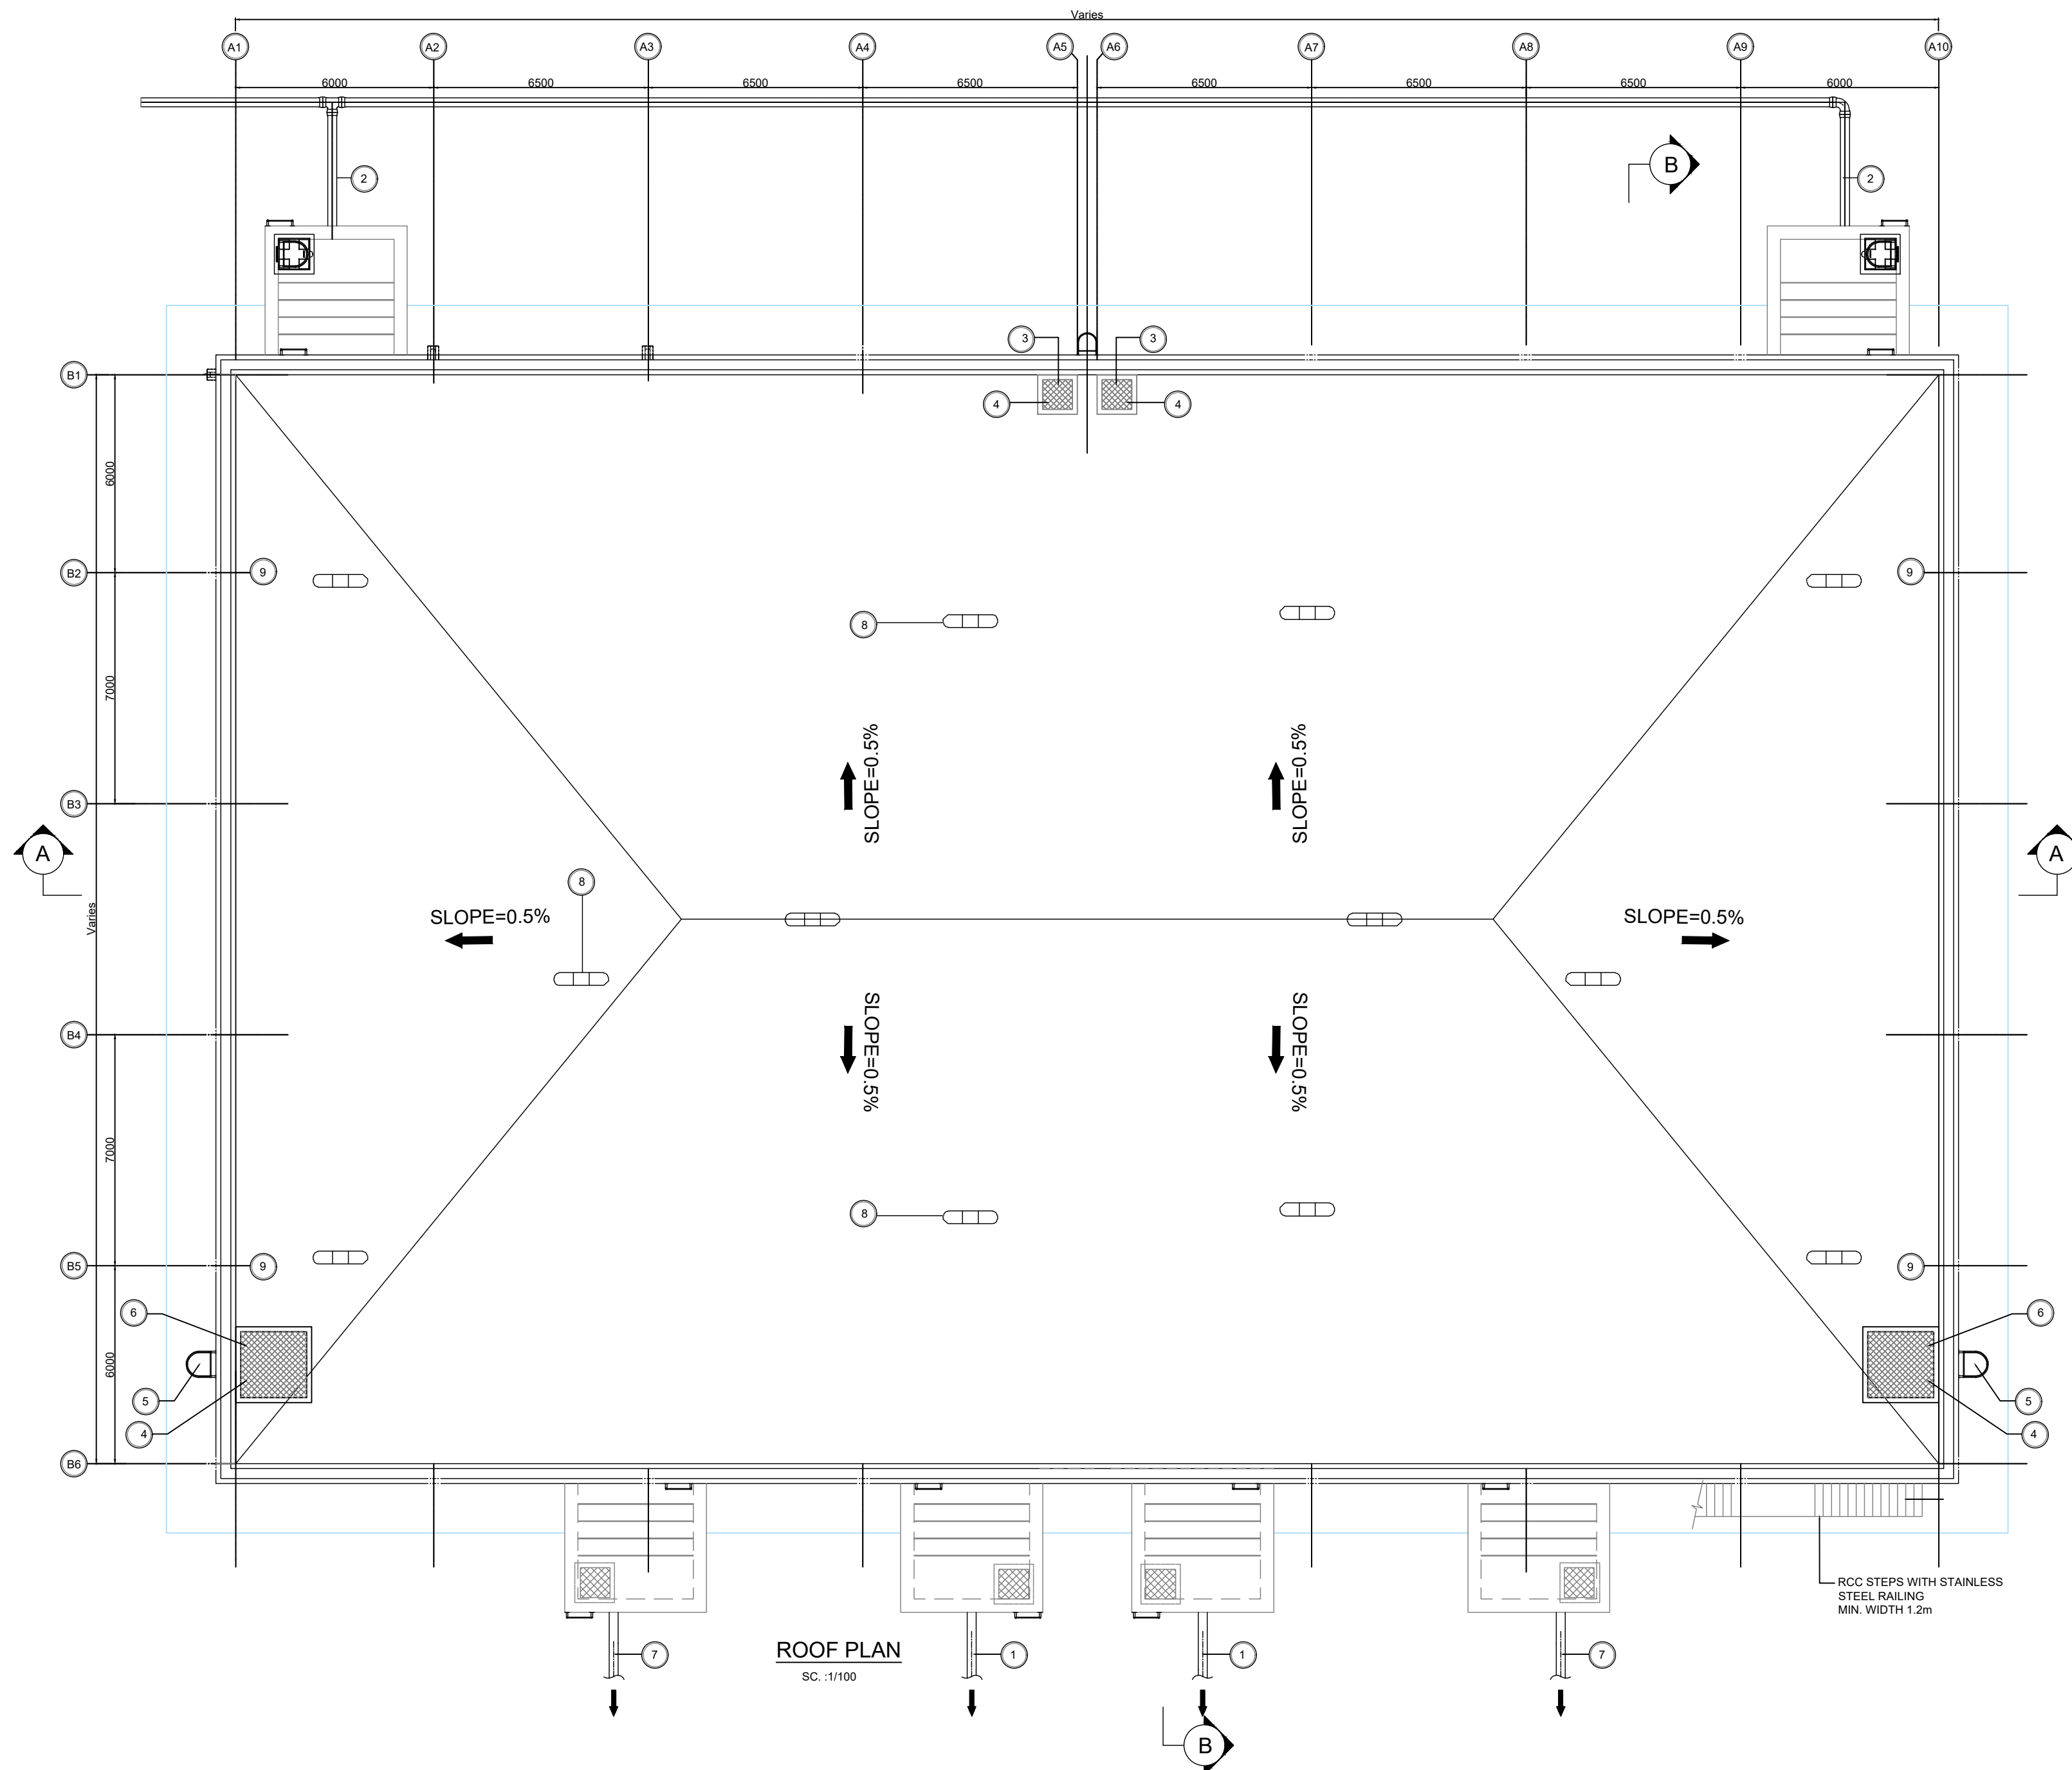

FOR TENDER

<div> <div> <div>CLIENT</div> <div>  </div> </div> <div> <div>MAHARASHTRA INDUSTRIAL TOWNSHIP LTD (MITL)</div> </div> </div>			
<div> <div>PROJECT</div> <div>DESIGN, CONSTRUCTION, TESTING, COMMISSIONING AND OPERATION & MAINTENANCE OF INFRASTRUCTURE WORKS AT DIGHI PORT INDUSTRIAL AREA (DPIA)- PHASE 1 UNDER DELHI MUMBAI INDUSTRIAL CORRIDOR (DMIC) ON EPC BASIS</div> </div>			
<div> <div>TITLE</div> <div>TYPICAL DETAILS OF GROUND TANK & ROOF PLAN</div> </div>			
<div> <div>PROJECT CODE: D11628</div> <div>STATUS: ISSUED FOR TENDER</div> <div>DATE: 18.12.2024</div> </div>			
<div> <div>SHEET NO: 01 OF 02</div> <div>SCALE: NTS</div> <div>DWG SIZE: A2</div> <div>REV NO: R0</div> </div>			
<div> <div>DRAWING NO:</div> <div>MITL-DPIA-PKG1-SW-08</div> </div>			